

ELECTRICAL NOTES: -ALL WORK AND MATERIALS SHALL CONFORM TO LATEST ADOPTED NATIONAL ELECTRICAL CODE/NFPA 70, AND ALL APPLICABLE STATE AND LOCAL CODES AND REGULATIONS REQUIREMENTS. -ELECTRICAL CONTRACTOR SHALL VERIFY CONDITIONS ON JOB SITE. COORDINATE WITH ARCHITECT FOR VARIATIONS PRIOR TO ANY WORK. - COORDINATE ALL WORK, PERMITS, CONNECTIONS, INSPECTIONS, ETC., WITH APPROPRIATE AUTHORITIES. -COORDINATE WITH UTILITY COMPANY AS REQUIRED. COORDINATE SERVICE ENTRANCE WITH SAME. -ELECTRICAL CONTRACTOR SHALL SIZE CIRCUITS, PANELS, ETC., AND PROVIDE ALL ACCESSORIES NECESSARY FOR A COMPLETE AND SAFE OPERATING SYSTEM. -ALL MATERIALS TO BE NEW AND U.L. APPROVED, WHERE REQUIRED. BRANCH CIRCUIT WIRING SHALL BE MIN. #12 AWG. WITH FULL GROUND TYPE NM COPPER. -COORDINATE WITH OTHER TRADES AS REQUIRED. -COORDINATE WITH TELEPHONE COMPANY. PREWIRE TELEPHONE -COORDINATE WITH OWNER FOR TYPE OF CABLE TV, CTV OUTLET LOCATIONS, AND LOCATIONS OF CONNECTOR W/ FUTURE SATELLITE DISH ANTENNA, IF SO DESIRED (UNDERGROUND). -PROVIDE ELECTRICAL SERVICE TÒ PHOTO CELL CONTROL FOR EXTERIOR LIGHTING, SELECT BEST LOCATION ON BUILDING. -PROVIDE 110V SMOKE DETECTORS, W/ BATTERY BACK-UP, AS NOTED ON PLAN. -COORDINATE WITH OWNER FOR SELECTION OF LIGHT FIXTURES & APPLIANCES. VERIFY LOADS ON APPLIANCES PRIOR TO ROUGH-IN. -PROVIDE A COMPUTER DEDICATED CIRCUIT, COORDINATE EXACT LOCATION OF OUTLET W/ OWNER. -PROVIDE EMERGENCY PÁNEL, MANUAL TRANSFER SWITCH AND GENERATOR PLUG. -PROVIDE A MIN. OF 2-3/4" DIA., 10'-0" LONG GROUND BARS. -PROVIDE TYPEWRITTEN DIRECTORY INSIDE PANEL DOOR, STATE ROOM NAME, CIRCUIT AND SPPLIANCES/FIXTURES SERVICED. -SERVICE SHALL BE 120 AMP. -ALL BRANCH CIRCUITS THAT SUPPLY 125 VOLT, SINGLE PHASE, 15 AMP AND 20 AMP OUTLETS INSTALLED IN DWELLING UNIT BATHROOMS SHALL BE PROTECTED BY AN ARC-FAULT CIRCUIT INTERRUPTER LISTED TO PROVIDE PROTRCTION OF THE ENTIRE BRANCH CIRCUIT AS PER NEC-2000 ARTICLE 210.12 (B) -PROVIDE ENERGY STAR LABELED APPLIANCES, LIGHT FIXTURES, AND INSTALL ENERGY STAR LIGHTING OUTDOORS WITH DAYLIGHT SENSORS OR TIMERS. -OUTLETS SHALL BE LOCATED 18" AFF (4'-0" AFF @ COUNTERS) & SWITCHES SHALL BE 4'-6" AFF FOR HANDICAPPED ACCESSIBLITY. -ELECTRICAL PANEL SHALL BE LOCATED IN UTILITY ROOM. MECHANICAL SYSTEMS -HEATING SYSTEM SHAL BE 8.5 OR 9.5 HSPF AIR SOURCE HEAT PUMP. -COOLING SYSTEM SHALL BE 15 OR 16 SEER AIR SOURCE HEAT PUMP. -DUCTWORK SHALL BE ATTACHED W/ MASTIC AT AIR HANDLER. -WATER HEATER SHALL BE ELECTRIC TANK 50 GALLON,EF=0.92 OR UPGRADE TO 2.0 EF HEAT PUMP WATER HEATER LOT B., SQ. 308, FOURTH DISTRICT NEW ORLEANS, LA. ORLEANS PARISH LOYOLA ST. (SIDE) 33.7.0' I LOT B. 22'-0"

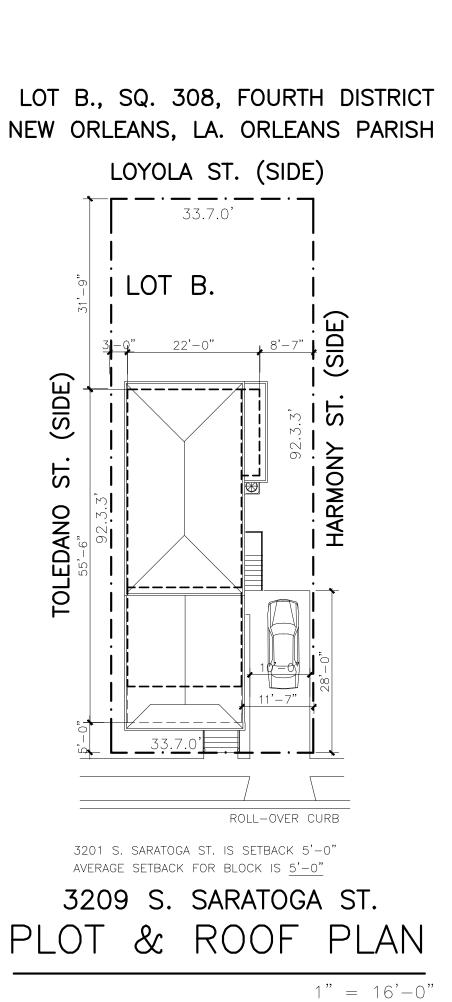

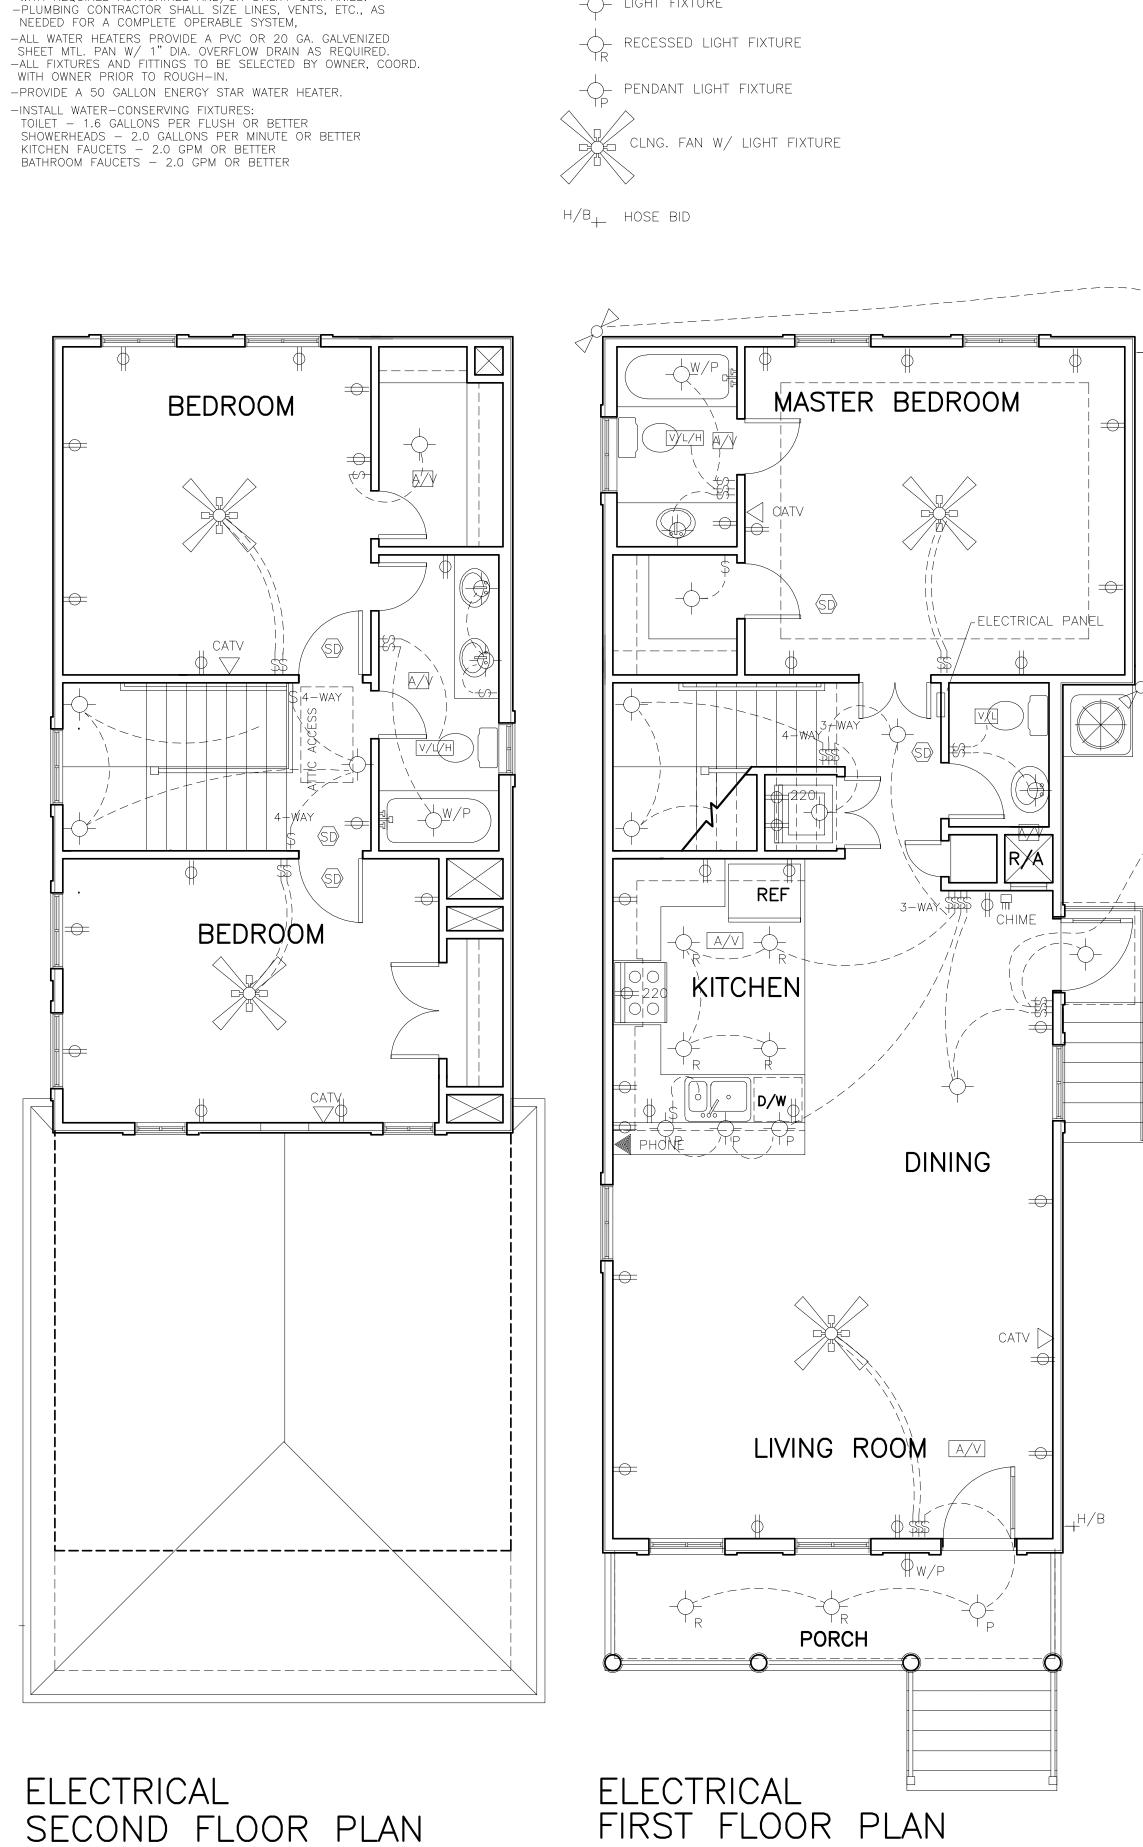

VENTALATION/EXHAUST NOTES:

PLUMBING NOTES:

FOUNDATION SUBCONTRACTORS.

-BATHROOM VENTILATORS SHALL WORK AT A RATE OF NOT LESS THAN 50 CFM FOR AN INTERMITTENT VENTILATOR OR 20 CFM FOR A CONTINUOUS VENTILATOR IN ACCORDANCE WITH R303.3 IRC 2012 ED.

-CLOTHES DRYERS MUST BE EXHAUSTED DIRECTLY TO THE OUTDOORS.

-ALL WORK AND MATERIALS SHALL CONFORM TO LATEST EDITION OF

NATIONAL PLUMBING CODE AND ALL OTHER APPLICABLE STATE AND

COORDINATE ALL WORK, PERMITS, CONNECTIONS, INSPECTIONS, ETC.

-COORDINATE WITH ALL TRADES AS REQUIRED, SPECIALLY WITH

-PLUMBING CONTRACTOR SHALL VERIFY CONDITIONS AT JOBSITE.

WITH REQUIRED AUTHORITIES AND/OR UTILITY COMPANIES.


-ATTIC SHALL BE PROPERLY VENTILATED IN ACCORDANCE WITH SEC. R806 IRC 2012 ED.

-INSTALL ENTERGY STAR LABELED POWER VENTED FANS OR

RANGE HOODS THAT EXHAUST TO THE EXTERIOR.

LOCAL CODES AND REGULATION REQUIREMENTS.

MIN. 3"x 11 1/4" NET HEADER FASTEN TOP PLATE TO HEADER WITH TWO ROWS OF 16D SINKER NAILS @ 3" O.C. TYP (S) SPEAKERS -1,000 LB STRAP OPPOSITE SHEATING — 16" MIN. WIDTH FOR 1 STORY STRUCTURE MIN. 2"x 4" FRAMING 3/8" MIN. THICKNESS FOR WOOD STRUCTURAL PANEL SHEATING _()_ LIGHT FIXTURE MIN. 4,200 LB. TIE-DOWN DEVICE (EMBEDDED INTO STRUCTURE & NAILED INTO FRAMING) 1,000 LB TIE DOWN DEVICE -LESS THAN 2'-7" OF SHEAR WALL EXIST CLNG. FAN W/ LIGHT FIXTURE

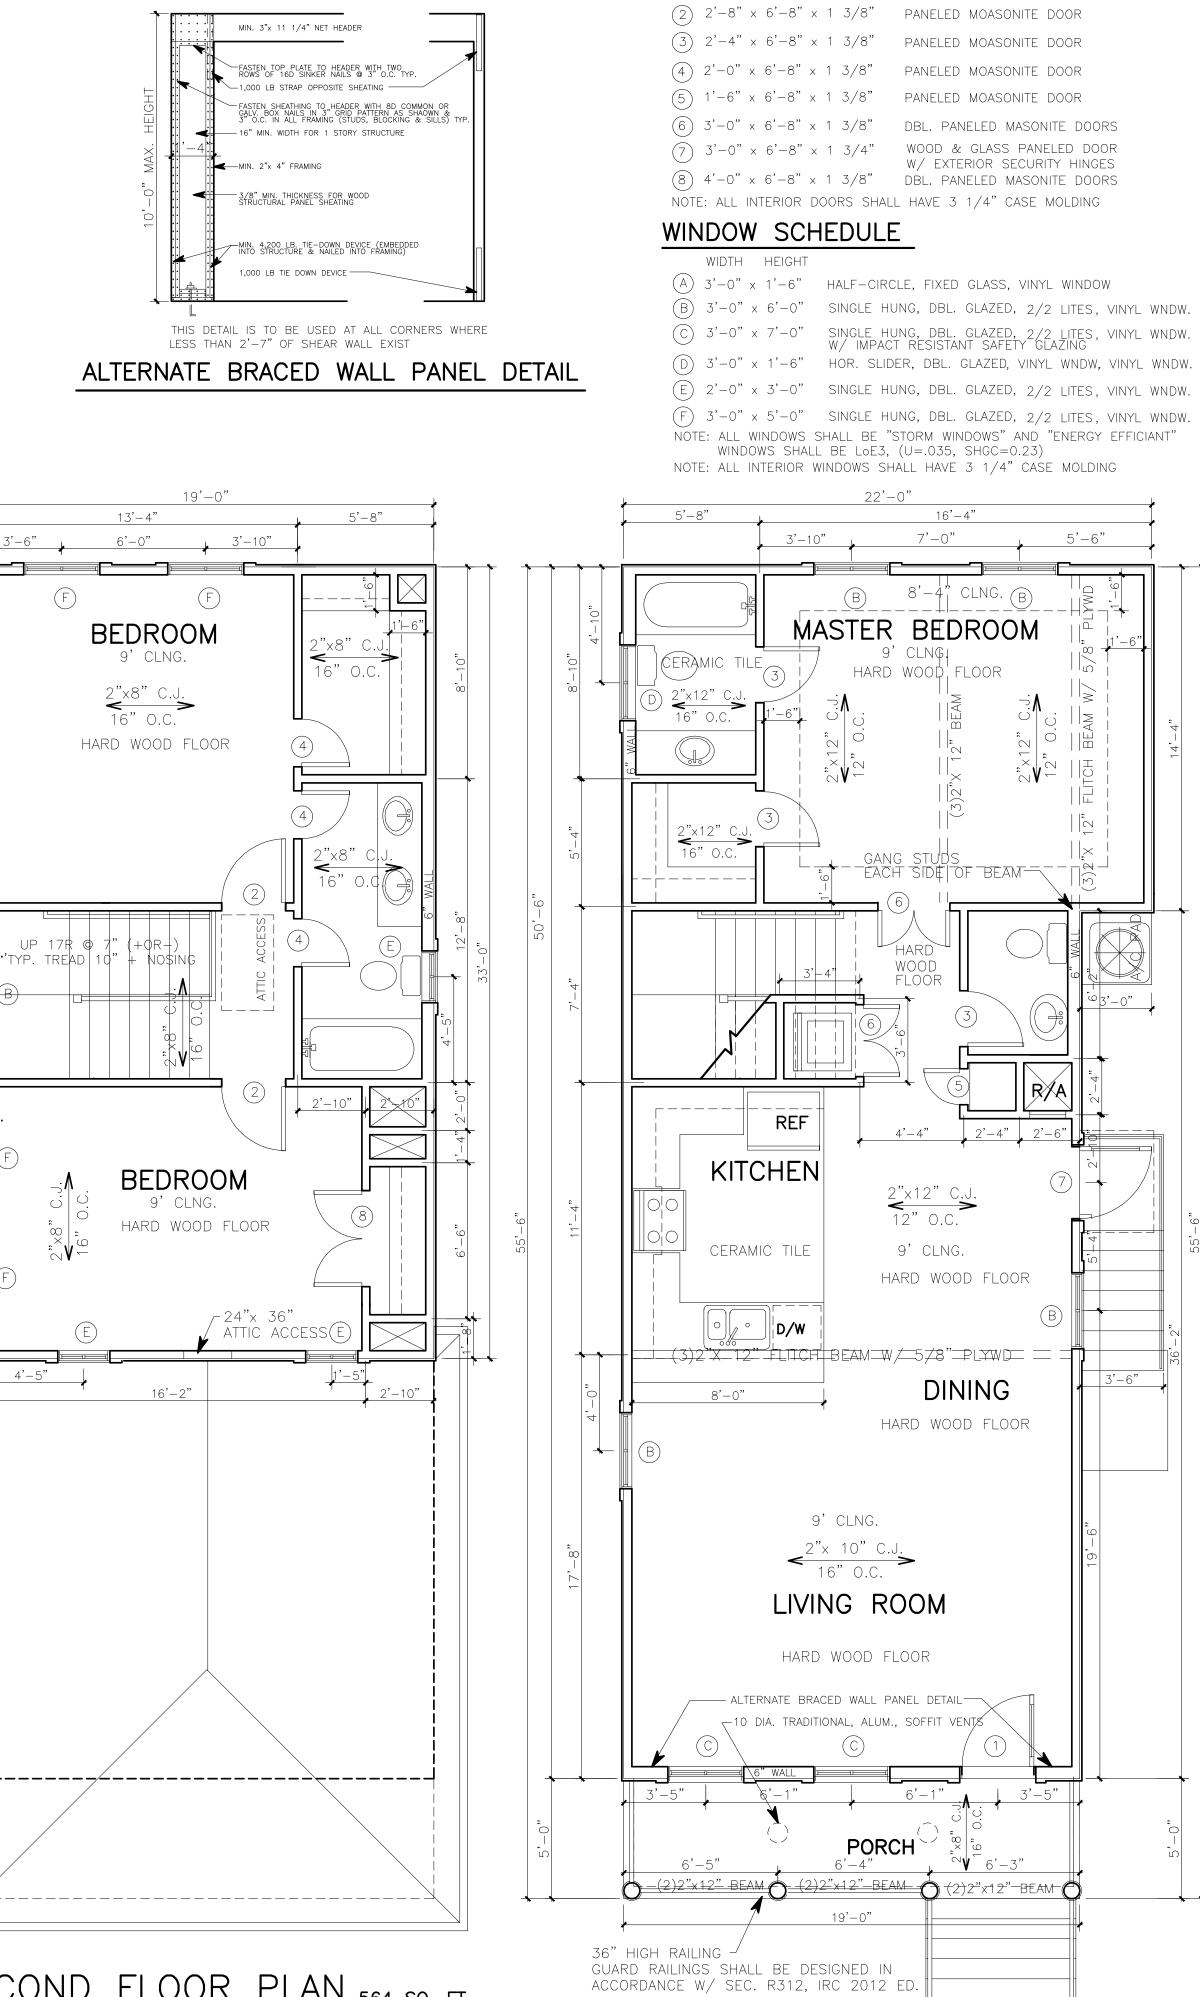



THESE PLANS HAVE BEEN PREPARED UNDER MY PERSONAL SUPERVISION & TO THE BEST OF Y KNOWLEDGE COMPLY WITH " IBC 2012 ed & THE IRC 2012 ed BUILDING CODES, I AM NOT SUPERVISEING CONSTRUCTION.

PLAN "G-1"

3209 S. SARATOGA Drawing Title

FLOOR PLAN & SITE PLAN Scale 1"=4'-0"

Date 10/1/2015 Drawn by M SCHROEDE

DOOR SCHEDULE WIDTH HEIGHT THICKNESS

SECOND FLOOR PLAN 564 SQ. FT.

TREAD TO RISER RATIO'S IN

ACCORDANCE WITH R311 IRC 2012 ed.

982 SQ. FT. LIVING / 114 SQ. FT. PORCH

SECOND FLOOR PLAN

ELECTRICAL SYMBOLS (SD) SMOKE DETECTOR

→ OUTLET (FLOOR OUTLET

TELEPHONE

CATV CABLE TV

- RECESSED LIGHT FIXTURE

- - - - - - - -

KITCHEN

-()- PENDANT LIGHT FIXTURE

MASTER BEDROOM

FELECTRICAL PANEL *_*/_______

DINING

LIVING ROOM A

CATV

H/B_ HOSE BID